


NOTE: PLANS DESIGNED UNDER 2012 NORTH CAROLINA RESIDENTIAL CODE.

REVISIONS: DATE: NAME: DRAWN BY: CDS CHECKED BY: JCD DATE: 3-19-15 PLAN NO. GARAGE **BOLTON-GAR** SHEET NO.

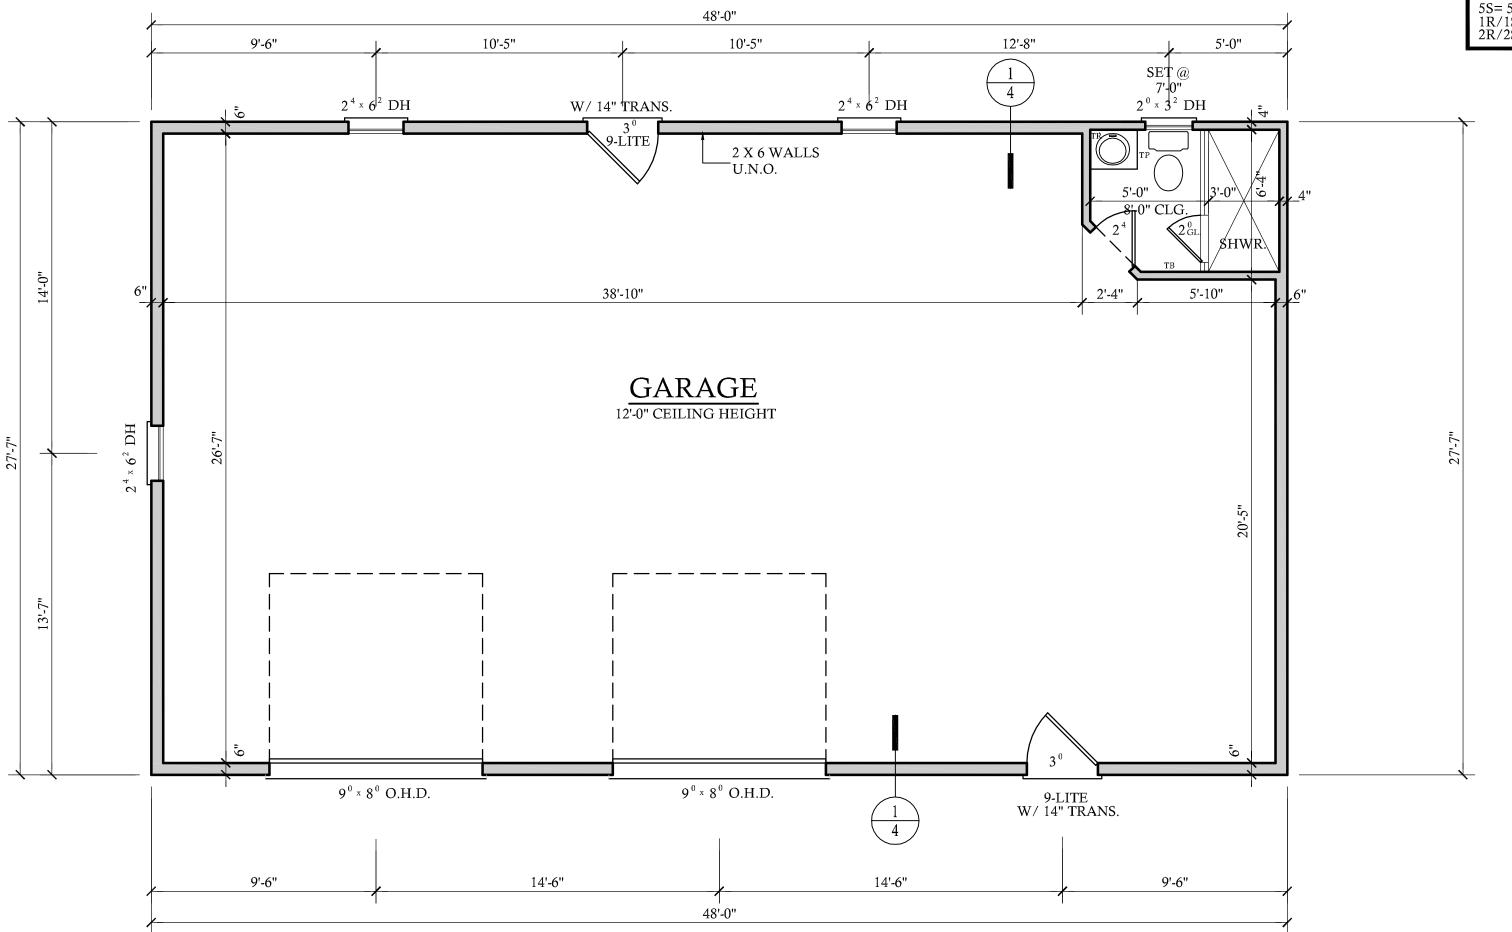

LIST OF ABBREVIATIONS

ABV.: ABOVE CLG.: CEILING HGT.: HEIGHT C.O.: CASED OPENING D.O.: DOUBLE OVEN REFG.: REFRIGERATOR WD.: WOOD D.W.: DISHWASHER CONT.:CONTINUOUS T.B.D.: TO BE DETERMINED CONC.: CONCRETE W.I.C.: WALK IN CLOSET COL.: COLUMN

W: WASHER ELLIP.: ELLIPSE D : DRYER W/: WITH SHWR.: SHOWER TRANS.: TRANSOM DN.: DOWN CANT.: CANTILEVER K.S.: KNEE SPACE M.O.: MASONRY OPENING TYP.: TYPICAL

5S= 5 SHELVES 1R/1S = 1 ROD AND 1 SHELF 2R/2S =2 RODS AND 2 SHELVES

ACCESSORIES LEGEND

PROVIDE BLOCKING FOR:

TB = TOWEL BAR

MR = MAGAZINE RACKMC = MEDICINE CABINET TP = TOILET PAPER

DATE:

NAME:

DRAWN BY:

CHECKED BY: JCD DATE: 3-19-15

PLAN NO. GARAGE

CDS

TR = TOWEL RINGNOTE:

SELECTION BY OWNER PER **BUILDER CONTRACT SPECIFICATIONS**

NOTES:

- 1.) SEE CHAPTER 6 OF 2012 NCRC FOR WALL CONSTRUCTION.
- 2.) TEMPERED GLASS TO BE USED AT ALL SAFETY REQUIRED LOCATIONS ACCORDING TO 2012 NCRC SECTION R308.4.
- 3.) DWELLING/GARAGE FIRE SEPARATION SHALL PER TABLE 302.6 OF 2012 NCRC.
- 4.) ALL HABITABLE ROOMS SHALL MEET LIGHT/VENTILATION & EGRESS AS REQUIRED IN 2012 NCRC SECTIONS R303.1 AND R310
- 5.) ALL ANGLED WALLS ARE 45° UNLESS NOTED OTHERWISE.
- 6.) VERIFY ALL WINDOW SIZES, RADIUS, AND DETAILS WITH CHOSEN MANUFACTURE.
- 7.) LOCATE DORMER FACE TO ALLOW 4" MIN. BELOW WINDOW FRAME.
- 8.) FLOOR PLAN NOTATIONS GOVERN OVER ELEVATION SCALE.
- 9.) ALL CABINET DESIGNS/LAYOUTS TO BE VERIFIED WITH OWNER VIA SHOP DRAWINGS FROM CABINET MANUF.
- 10.) ALL FLOOR COVERINGS AND FINISHES BY OWNER/ BLDR. COORDINATE HEIGHTS DUE TO THICKNESS CHANGES.
- 11.) ALL WINDOW GLAZING TO HAVE 0.35 U-FACTOR MIN. SEE TABLE N1102.1, N1102.1.2
- 12.) FINISHES OF SCREEN PORCH COLUMNS, RAILS, FLOORS, CEILINGS; SCREEN DOOR SYSTEM, AND DOOR TO PORCH BY BLDR. & OWNER, PER CONTRACT SPECIFICATIONS
- 13.) FINISHES FOR CLOSET SHELVING AND ROD BY BLDR. & OWNER, PER CONTRACT **SPECIFICATIONS**
- 14.) FINISHES OF ALL INTERIOR BASE BOARD, CLG. DETAIL / MOLDING, OPENING DETAILS, PASS-THRUS, WAINSCOTTING DETAILS BY BLDR. & OWNER, PER CONTRACT SPECIFICATIONS

FIRST FLOOR PLAN

12'-0" CLG. HGT. U.N.O.


SET WINDOWS @ 8'-0" U.N.O.

SCALE: 1/4"=1'-0"

1324 SQ.FT.

SHEET NO.

BOLTON

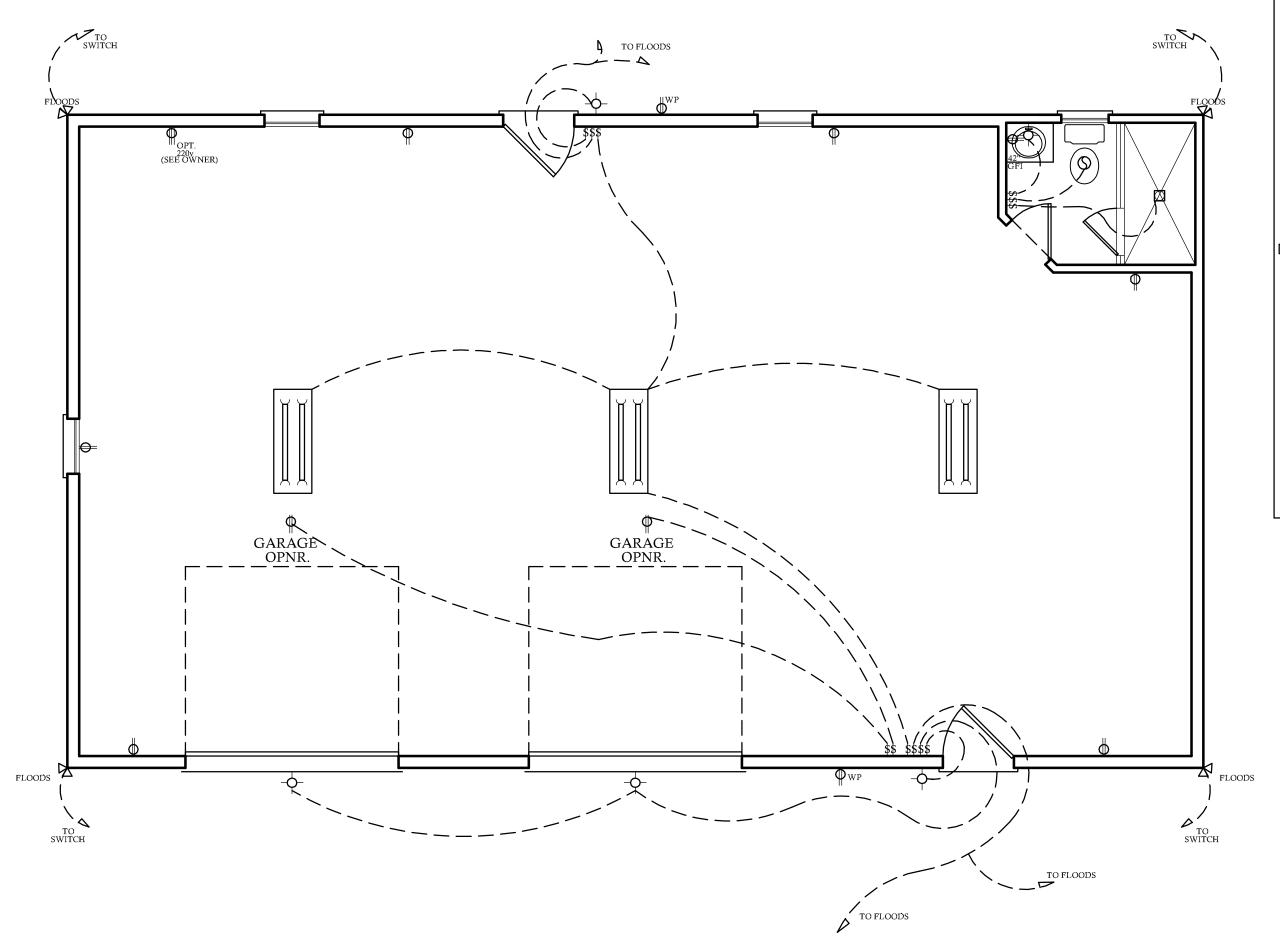

FIRST FLOOR ELECTRICAL PLAN

ELECTRICAL LEGEND

-**♦**- - LIGHT FIXTURE

S - FAN/LIGHT

♦ WP WATERPROOF OUTLET

- RECESSED LIGHTING

□ CAN LIGHT W/ FAN

\$ - SINGLE SWITCH

\$ - 3-WAY SWITCH

\$ - 4-WAY SWITCH

\$ - DIMMER SWITCH

CARBON MONOXIDE DETECTOR SMOKE DETECTOR

► FLOOD LIGHTS


▼ - EYEBALL SPOTS

- DUPLEX RECEPTACLE (110V)

- 220 VOLT RECEPTACLE

• SWITCHED RECEPTACLE (TOP WIRE ONLY)

GFI - GROUND FAULT CIRCUIT INTERRUPTOR

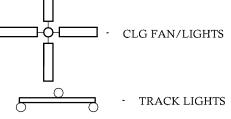

FLUORESCENT LIGHTING

- CABLE OUTLET

▲ - TELEPHONE OUTLET

 Δ - COMPUTER DATA OUTLET

☐ - INTERCOM

ALL ELECTRICAL INSTALLATIONS SHALL BE IN ACCORDANCE WITH THE NEC.

ELECTRICAL NOTES:

- THE ELECTRICAL DIAGRAMS SHOWN ON THESE PLANS ARE TO BE USED AS A GUIDE. HOME OWNER AND BUILDER ARE REQUIRED TO REVIEW AND CONFIRM WITH LICENSED ELECTRICAL CONTRACTOR THESE CONTENTS PRIOR TO ROUGH-IN FOR CODE COMPLIANCE AND SPECIAL REQUIREMENTS BY THE HOME OWNER. ONCE CONSTRUCTION BEGINS, IT IS THE RESPONSIBILITY OF THE CONTRACTOR, NOT DESIGN TECH, INCORPORATED.
- SEE ELECTRICIAN, BUILDER, AND OWNER FOR POSSIBLE GENERATOR LOCATION, SWITCHES, RECEPTACLES, AND ATTACHMENTS. COORDINATE SIZE AND MODEL OF GENERATOR TO HANDLE LOADS ADEQUATELY.
- UNDER-CABINET COUNTER LIGHTING FOR KITCHEN IS OPTIONAL. PLEASE CONFIRM WITH CABINET MAKER AND ELECTRICIAN.
- 4. ELECTRICAL FOR EXTERIOR LANDSCAPE LIGHTING AND POOL EQUIPMENT BY BUILDER AS PER CODE.
- 5. IT IS AN OPTION FOR EVERY TOP RECEPTACLE AT FRONT WINDOWS TO BE ON ONE SWITCH LOCATED BY OWNER/ BUILDER FOR WINDOW DECORATION LIGHTING.
- 6. CLOSET LIGHTING TO BE CONTROLLED BY SWITCH AS SHOWN OR IN-JAMB SWITCH WHICH WOULD ILLUMINATE LIGHT WHEN DOOR IS OPENED. SOME ELECTRICAL PLANS MAY OR MAY NOT SHOW CLOSET LIGHTING. SEE OWNER AND CONFIRM WITH BUILDER.
- 7. EXHAUST FANS ARE REQUIRED IN BATHROOMS WITHOUT NATURAL VENTILATION. OUR PLANS WILL ALWAYS SHOW EXHAUST FAN.
- 8. NO HEAT LAMPS OR HEATERS MAY BE SHOWN IN THIS DRAWING. PLEASE CONFIRM WITH BUILDER FOR PRESENCE AND LOCATION.
- 9. ALL SLEEPING AREAS/BEDROOMS SHOULD CONTAIN SMOKE DETECTORS. SOME CORRIDORS ALSO REQUIRE SMOKE DETECTORS. PLEASE SEE LOCAL, STATE, AND FEDERAL BUILDING CODES TO CONFIRM THESE REQUIREMENTS.
- 10. PANEL BOX LOCATION BY ELECTRICIAN/BUILDER AS PER CODE.



NAME:

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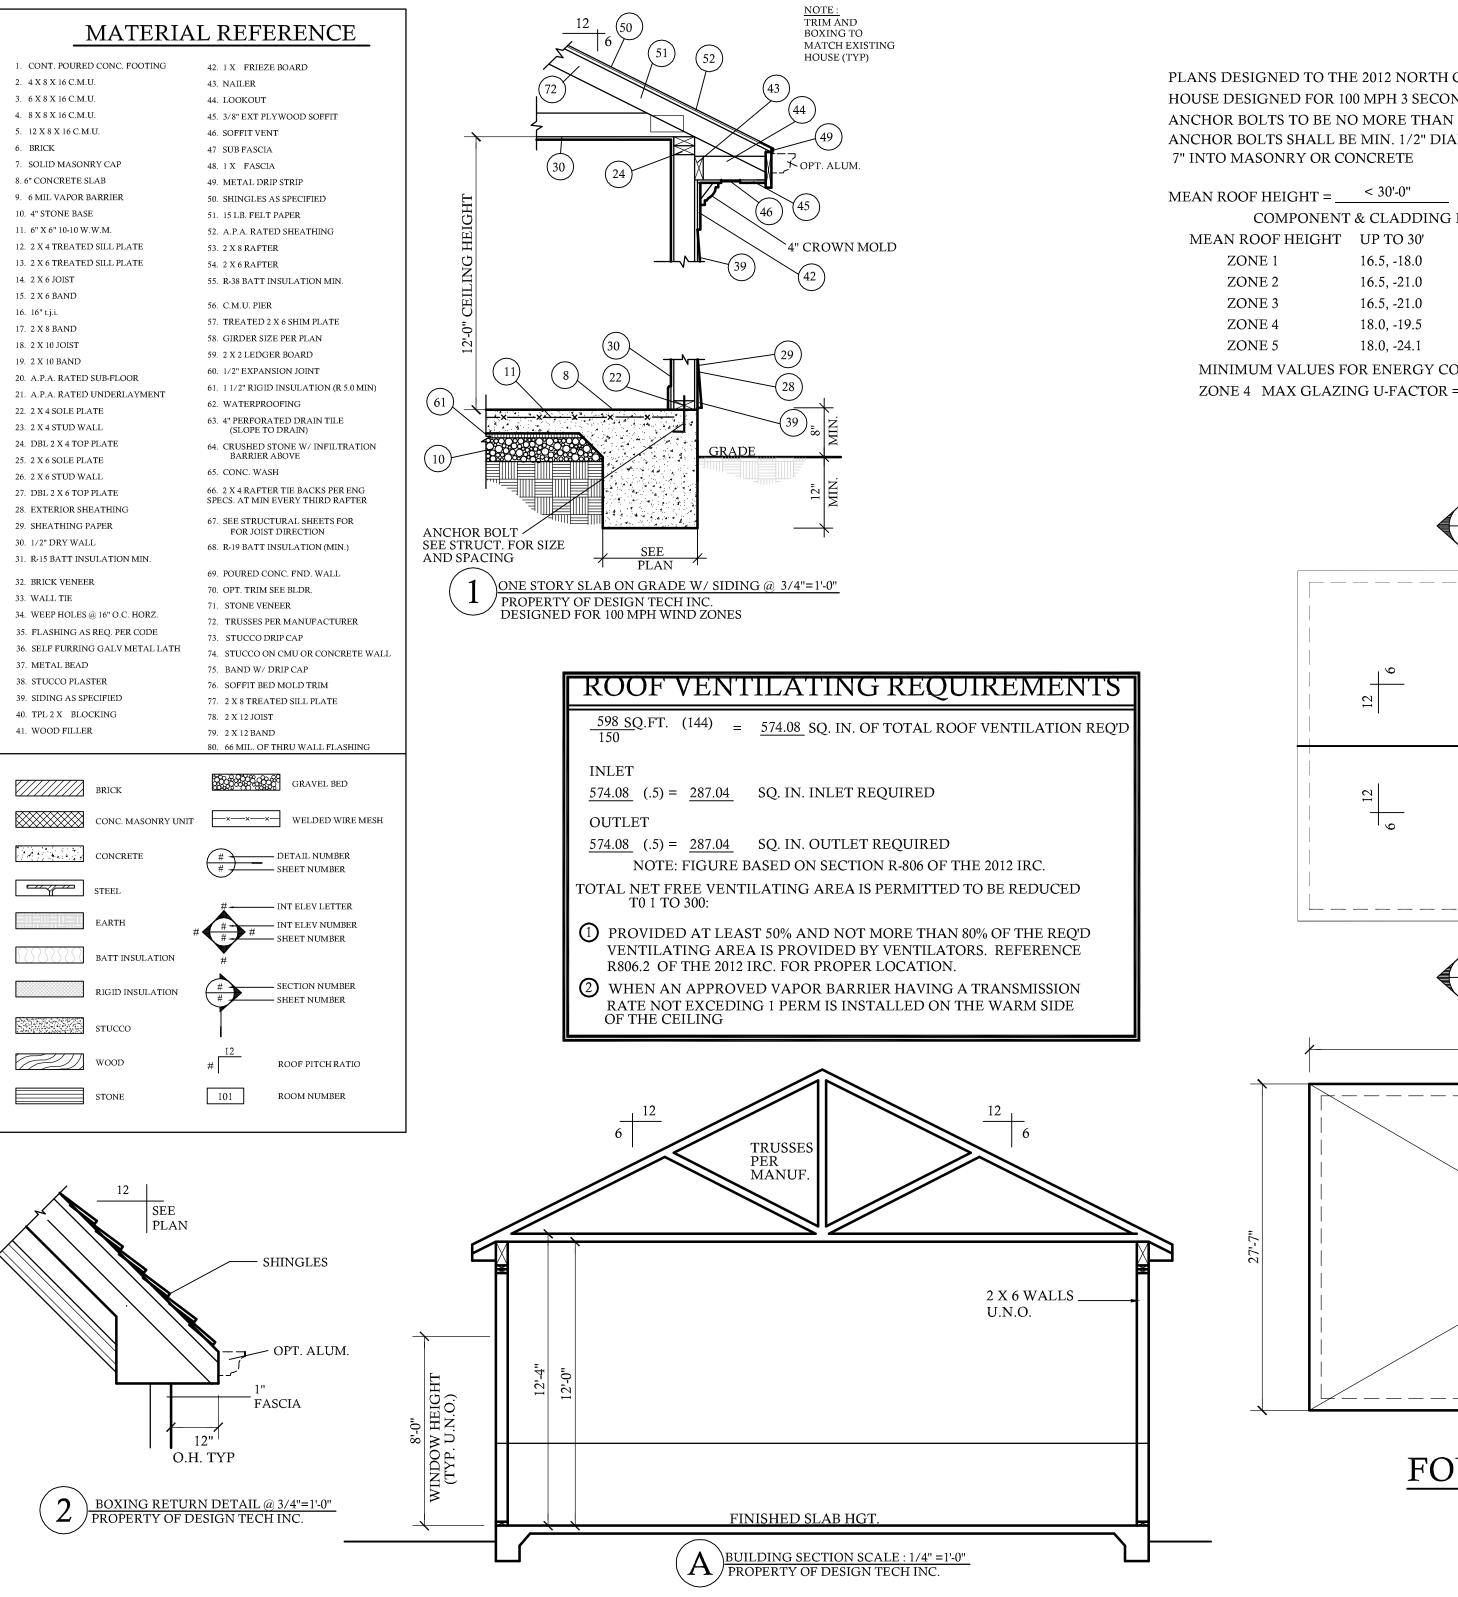
CHECKED BY: JCD

CDS

DATE: 3-19-15 PLAN NO.

GARAGE

BOLTON





PLANS DESIGNED TO THE 2012 NORTH CAROLINA RESIDENTIAL CODE HOUSE DESIGNED FOR 100 MPH 3 SECOND GUST (80 FASTEST MILE), EXPOSURE B ANCHOR BOLTS TO BE NO MORE THAN 6' O.C. AND WITHIN 12" OF ALL PLATES SPLICES ANCHOR BOLTS SHALL BE MIN. 1/2" DIAMETER & SHALL EXTEND A MINIMUM

COMPONENT & CLADDING DESIGNED FOR THE FOLLOWING LOADS				
MEAN ROOF HEIGHT	UP TO 30'	30'-1" - 35'	35'-1" - 40'	40'-1" - 45'
ZONE 1	16.5, -18.0	17.3, -18.9	18.0, -19.6	18.5, -20.2
ZONE 2	16.5, -21.0	17.3, -22.1	18.0, -22.9	18.5, -23.5
ZONE 3	16.5, -21.0	17.3, -22.1	18.0, -22.9	18.5, -23.5
ZONE 4	18.0, -19.5	18.9, -20.5	19.6, -21.3	20.2, -21.8
ZONE 5	18.0, -24.1	18.9, -25.3	19.6, -26.3	20.2, -27.0

MINIMUM VALUES FOR ENERGY COMPLIANCE:

ZONE 4 MAX GLAZING U-FACTOR = 0.35 CEILING R-38 WALLS R-15 FLOORS R-19

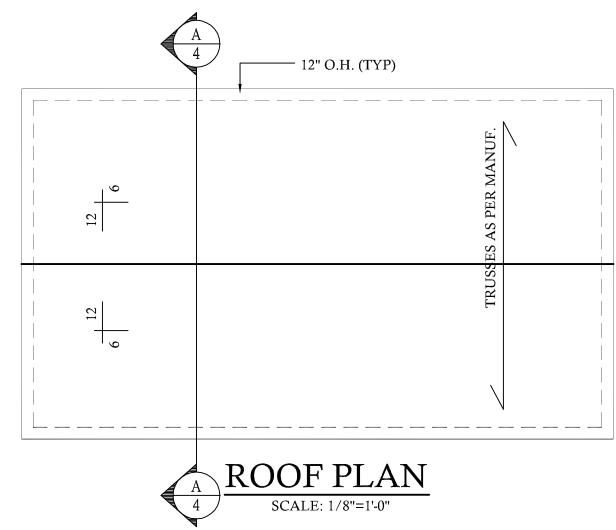

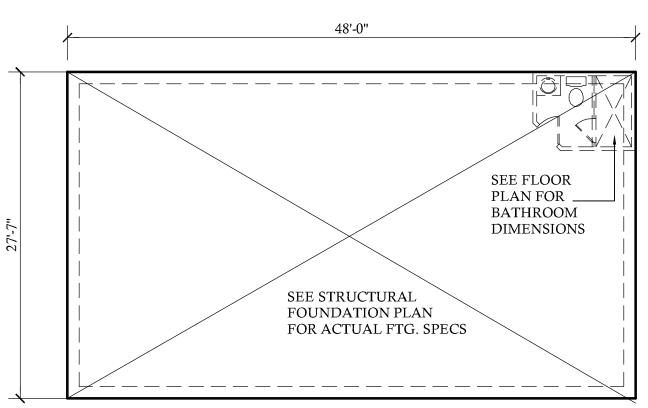

FOUNDATION PLAN SCALE: 1/8"=1'-0"

BOLTON-GAR

DATE:

NAME:

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CHECKED BY:

CDS

JCD

DATE:

3-19-15

PLAN NO.

GARAGE

SHEET NO.